

Amendment Issue Date

Project

PROPOSEDNEW DWELLING 11 LOADER PARADE NAROOMA

Drawing Title

WORKING DRAWINGS SITE PLAN

Project No

05:21



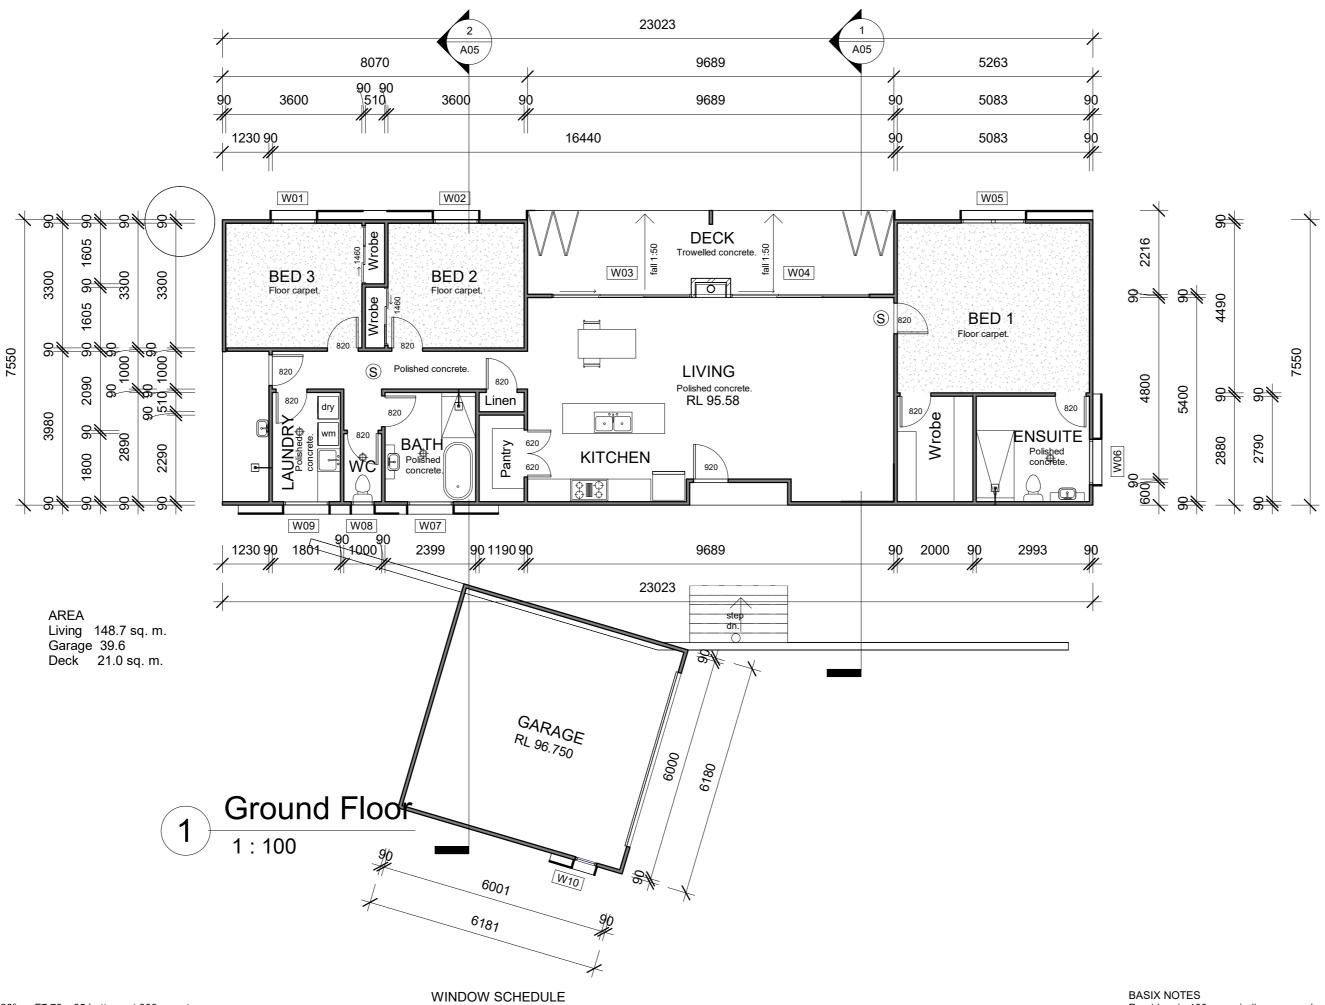
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21/05/2021

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CONSTRUCTION NOTES

Selected metal at 36° on F7 70 x 35 battens at 900 mm cts. Rafters F7140 x 45 at 900 cts to Living area. Trusses to balance, to manufactures specifications Garage water directed to storage tank.

Ground Floor - external walls F7 90 x 35 timber frames with selected metal cladding. Internal walls 90 x 35 F7 timber frame with 10 mm plasterboard.

CEILINGS Living area coffered ceiling at 3300 mm with 10 mm plasterboard. Balance flat at 2400 mm.

WINDOWS Aluminium framed windows single glazed. (see window schedule). All windows fitted with screens which comply with AS 3959.9.5.1A

FOOTINGS Retaing walls reinforced concrete blocwork on mass concrete footings. Footings and slab to engineers specifications. Provide 0.2 mm vapour barrier under slab.

DRIVEWAY Concrete & Gravel on underlay panels.

Sarking under all roofing.

### RETAINING WALLS

200 mm concrete blockwork with reinforced concrete infill on mass concrete footing to engineers specifications.

Provide smoke detectors as indicated. Provide bifold screens to deck, screens to comply with AS3959.9.5.1A Provide 4500 litre water tank. All roof water directed to water tank & over flow from tank directed to Growlers Gully via rubble drain. Provide wood burning heater as indicated, heater to comply wit AS/NZS 2918:2000

### Basix Group North

W01 1800 x 1200 aluminium framed single glass double hung. W02 1800 x 1200 aluminium framed single glass double hung. W03 2100 x 3600 aluminium framed single glass sliding door. W04 2100 x 3600 aluminium framed single glass sliding door. W05 1800 x 1800 aluminium framed single glass double hung.

### Basix Group East

W06 600 x 1200 aluminium framed single glass sliding.

## Basix Group South

W07 600 x 1200 aluminium framed single glass sliding. W08 600 x 600 aluminium framed single glass sliding. W09 600 x 1200 aluminium framed single glass sliding.

W10 Not included in Basix calculations 1800 x 600 aluminium frame single glass fixed. Amendment Issue Date

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**WORKING DRAWINGS** FLOOR PLAN

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IKW 03

Provide min 100 sq. m indigenous or low water use species to garden WATER Provide min. 2000 Litre rainwater tanks connected to:

All toilets in development. The cold water tap that supply the clothes washer. At least one outdoor tap. Rainwater tanks to collect water from 36 sq metres of roof.

Showerheads min 4 star.(>6.0 But<=7.5 L/min)) in all howers in the development.

min 5 star.

Kitchen Taps min 5 star.

Bathroom Taps min 5 star.

THERMAL COMFORT:

External Wall 2.22 (or 2.60 including construction)

Ceiling and Roof - flat ceiling / pitched roof - ceiling: R4.0 (up), roof: foil/sarking. Ceiling and roof - raked ceiling /pitched roof: R4.0 (up), roof: foil/sarking.

Roof unventilated; dark (solar absorptance >0.70)

ENERGY Hot water - Gas instantaneous with performance of 4.5 stars.

Cooling System - Living Room 3 phase airconditioning, energy rating EER 3.5 - 4.0 - Bedrooms 3 phase airconditioning, energy rating EER 3.5 - 4.0 Heating System - Living Room 3 phase airconditioning, energy rating EER 3.5 - 4.0

- Bedrooms 3 phase airconditioning, energy rating EER 3.5 - 4.0 The heating sysyem must provide for day/night zoning between Living areas and Bedrooms

Ventilation : Kitchen - Fan not ducted , controlled manual switch. Bathroom - Fan ducted to roof, controlled manual switch.

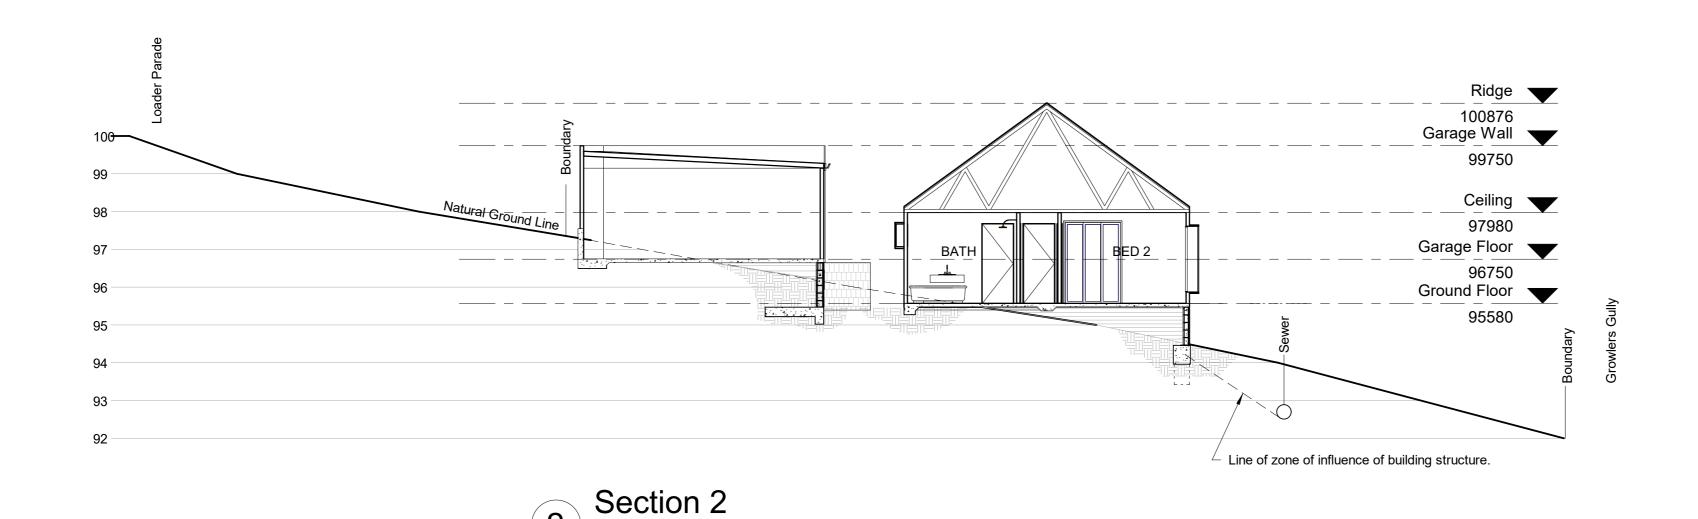
Laundry - natural ventilation.

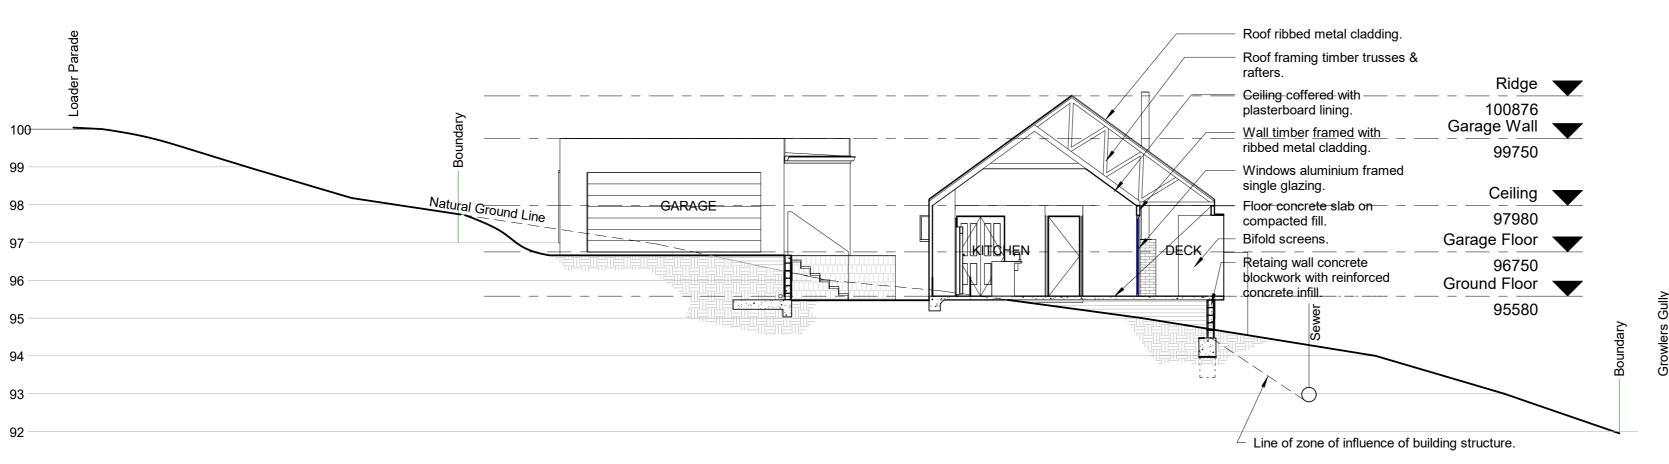
Each refrigerator space must be constructed to provide well ventilated space.

Artificial Lighting - The primary type of artificial lighting in the following rooms shall be fluorescent or light emitting diode.
All Bedrooms, Bathrooms, Kitchen, Toilets, Hallways & Living Areas

Gas cook top and electric oven to be provided to kitchens. A fixed outdoor clothes drying line must be installed.







Section 1

1: 100

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PROPOSEDNEW DWELLING 11 LOADER PARADE NAROOMA

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WORKING DRAWINGS SECTIONS

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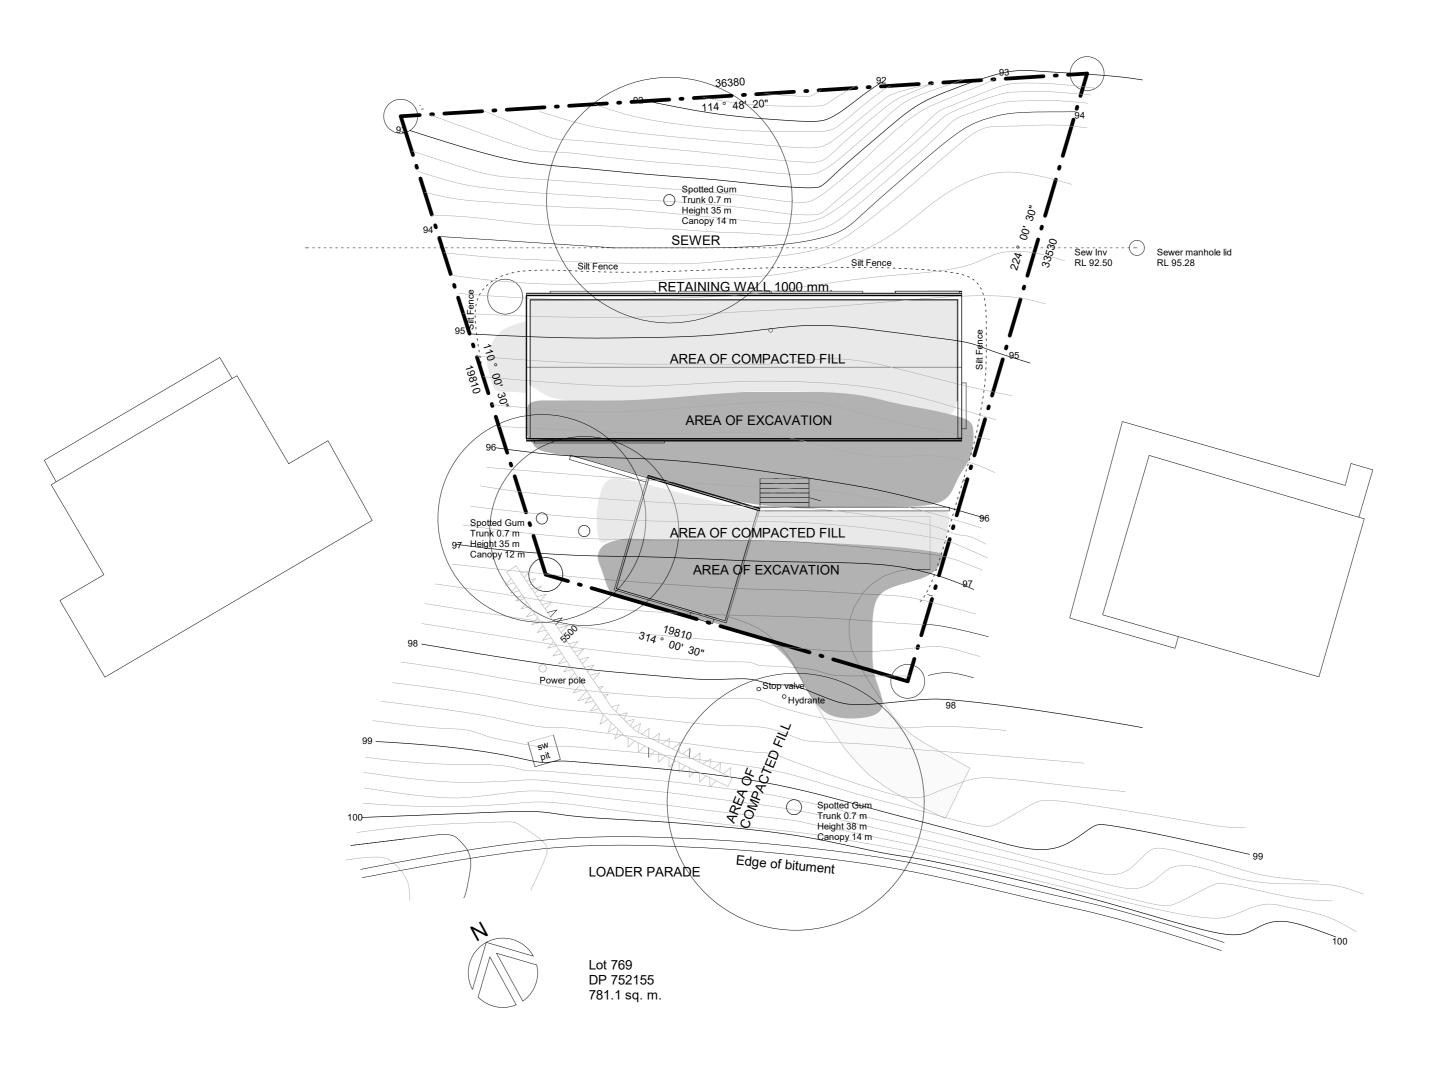
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08/12/2021

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Earthworks

1:200

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PROPOSEDNEW DWELLING 11 LOADER PARADE NAROOMA

Drawing Title

WORKING DRAWINGS EARTHWORKS

Project No

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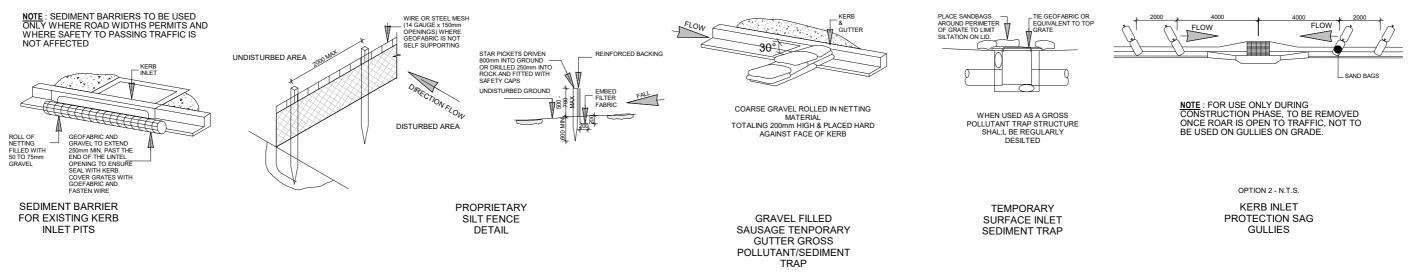
21/05/2021

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- 1. ALL RUN OFF AND SEDIMENT CONTROL STRUCTURES WILL BE MAINTAINED IN A FUNCTIONAL CONDITION
- 3. AREAS NOT USED FOR BUILDING SHOULD BE RETAINED WITH VEGETATION
- 4. REVEGETATION ON RETAIN CUT AND FILLS AS SOON AS POSSIBLE DURING

### SEDIMENT CONTROL NOTES:

- 1. ALL EROSION AND SEDIMENTATION CONTROL MEASURES, INCLUDING RE-VEGETATION AND STORAGE OF SOIL AND TOPSOIL, SHALL BE IMPLEMENTED TO THE STANDARDS OF THE SOIL CONSERVATION OF NSW.
- 2. ALL DRAINAGE WORKS SHALL BE CONSTRUCTED AND STABILIZED AS EARLY AS POSSIBLE DURING
- 3. SEDIMENT TRAPS SHALL BE CONSTRUCTED AROUND ALL INLET PITS, CONSISTING OF 300mm WIDE X 300mm DEEP TRENCH.
- 4. ALL SEDIMENT BASINS AND TRAPS SHALL BE CLEANED WHEN THE STRUCTURES ARE A MAXIMUM OF 60 % FULL OF SOIL MATERIALS, INCLUDING THE MAINTENANCE PERIOD.
- 5. MINIMISE ALL DISTURBED AREAS AND SHALL BE RE-VEGITATED AS SOON AS THE RELEVANT WORKS ARE COMPLETED.
- 6. SOIL AND TOPSOIL STOCKPILES SHALL BE LOCATED AWAY FROM DRAINAGE LINES, FOOTPATHS AND ANY AREA WHERE WATER MAY CONCENTRATE.
- 7. FILTER SHALL BE CONSTRUCTED BY STRETCHING A FILTER FABRIC (PROPEX OR APPROVED EQUIVALENT BETWEEN POST AT 3.0m CENTERS. FABRIC SHALL BE BURIED 150mm ALONG ITS LOWER
- 8. DUST PREVENTION MEASURES TO BE MAINTAINED AT ALL TIMES.
- 9. DRAINAGE IS TO BE CONNECTED TO STORMWATER SYSTEM AS SOON AS POSSIBLE.
- 10. ROADS AND FOOTPATH TO BE SWEPT DAILY.



# SEDIMENT CONTROL DETAILS NTS

### SPECIFICATION

General

Drawings are prepared from information supplied by the owner.

All dimensions are in millimetres unless otherwise noted.

It is the responsibility of the builder to verify all dimension on site.

Do not scale off drawings.

These plans are to be read in conjunction with Engineers Drawings.

### STATUTORY REQUIREMENTS

All work to be carried out in accordance with the NCC, conditions imposed by the local authority and commitments outlined in the relevant Basix Certificate.

The builder shall comply with all the requirements of the legally constituted authorities having jurisdiction over the building works and provision of the Home Building Act. Prior to the commencement of building work, the builder shall provide temporary

toilet facilities for the use of subcontractors.

On completion the builder shall remove the facility.

### NCC REQUIREMENTS

All earthworks shall be be in accordance with the engineers details and Part 3.1.1 of NCC. All excavation and under floor fill shall be in accordance with the engineers details and Part 3.2.2 of NCC.

Primary building elements are to be protected from subterranean termites in accordance with Part 3.1.3 of NCC.

Storm water drainage shall be carried out in accordance with Part 3.1.2 of NCC .

All timber framework shall comply with Part 3.4.2 of NCC or AS 1684.

Roof trusses shall be designed in accordance with AS 1720, and erected, fixed and braced in

accordance with the manufactures instructions.

All strip and sheet flooring shall be installed in accordance with AS 1684.

All metal fittings used in structural timber joints and bracing must have corrosion protection.

All steel framing shall be in accordance with manufactures specifications and Part 3.4.2 of NCC. All roof cladding shall comply with Part 3.5.1 of NCC and be installed in accordance with

manufactures specifications.

Gutters and down pipes shall be in accordance with Part 3.5.2 of NCC.

Sarking shall comply with AS/NZS 4200.1 & 2.

Flashing shall comply with Part 3.3.4 of NCC.

Clay brickwork shall comply with Part 3.3 of NCC, AS/NZS 4455. AS/NZS 4456 & AS 3700.

Concrete block work shall be constructed in accordance with Part 3.3 of NCC.

Damp proof courses shall comply with Part 3.3.4 of NCC.

Cavity ventilation must be provided in accordance with Part 3.3.4 of NCC.

Motor shall comply with Part 3.3.1 of NCC and joint tolerance shall be in accordance with AS 3700. Masonry accessories shall comply with Part 3.3.3. of NCC. Appropriate ties shall be provided

to articulated masonry joints.

Lintels used to support brickwork over wall openings shall comply with Part 3.3.1 of NCC and be protected from corrosion in accordance with Part 3.4.4 of NCC.

Engaged piers in single skin masonry walls shall be constructed in accordance with Part 3.3.1 of NCC (350 x 230 for N1 & N2 wind classification, 350 x 350 + Y12 vertical bar for N3 wind classification, 1800 spacing type, as per Fig. 3.3.21.2)

Internal wet areas shall be waterproofed in accordance with Part 3.8.1 of NCC. Wet area wall linings is to be fixed in accordance with manufactures specifications.

All timber doors and door sets shall be manufactured in accordance with AS 2688 & AS 2689 unless listed otherwise in the Schedule of Works.

Windows and doors shall be manufactured and installed in accordance with AS 2047. All plumbing shall comply with the requirements of the relevant supply authority

AS 3500, and be carried out by a licensed plumber.

All electrical work shall comply with the requirements of the relevant supply authority

of NCC if indicated on Plans.

AS/ NZS 3000, and be carried out by a licensed electrician.

All gas installations shall comply with the requirements of the relevant supply authority and

and be carried out by a licensed gas fitter.

Provide and install hard wired smoke alarms in accordance with AS 3786 and Part 3.7.2 of NCC.

Installation of wall and floor tiles shall be in accordance with AS 3958.1.

Building is to sealed to the requirements of NSW Part 3.12.3 of NCC, including chimneys, flues, roof lights, external windows and doors, exhaust fans, roof, walls and floors.

Services are to be installed in accordance with NSW Part 3.12.5 of NCC, including hot water supply, insulation of services, central heating, water piping and heating

and cooling ductwork.

Mechanical ventilation is to be installed in accordance with Part 3.8.5 of NCC.

Inward swinging WC doors are to be fitted with lift of hinges to comply with Part 3.8.3.3

Stairs Handrails and Balustrades are to be installed in compliance with NCC requirements, 3.9.1 and 3.9.2

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WORKING DRAWINGS
SEDIMENT CONTROL
& SPECIFICATIONS

Project N

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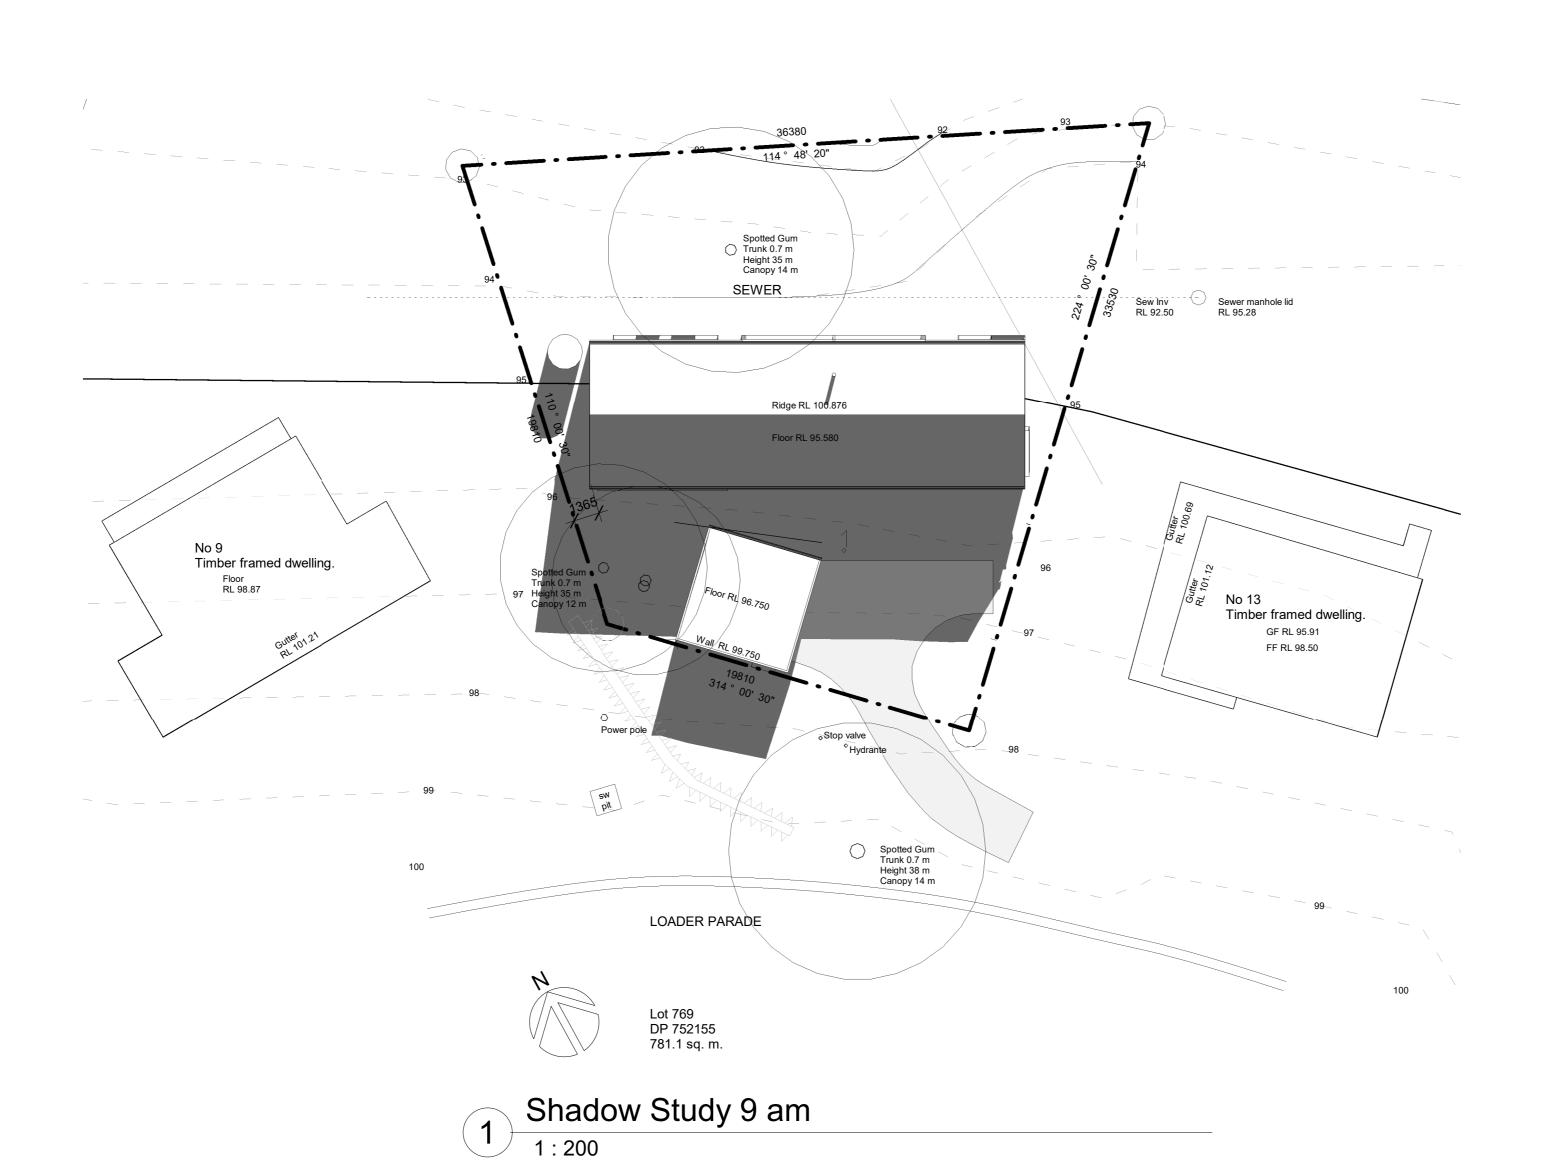


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Drawn

21/05/2021

Drawing No.



21st June

Altitude 16.6 Azimuth 42.8 Amendment Issue Date

Proj

PROPOSEDNEW DWELLING 11 LOADER PARADE NAROOMA

Drawing Title

WORKING DRAWINGS SHADOW STUDY 9:00 AM

Project N

05:21



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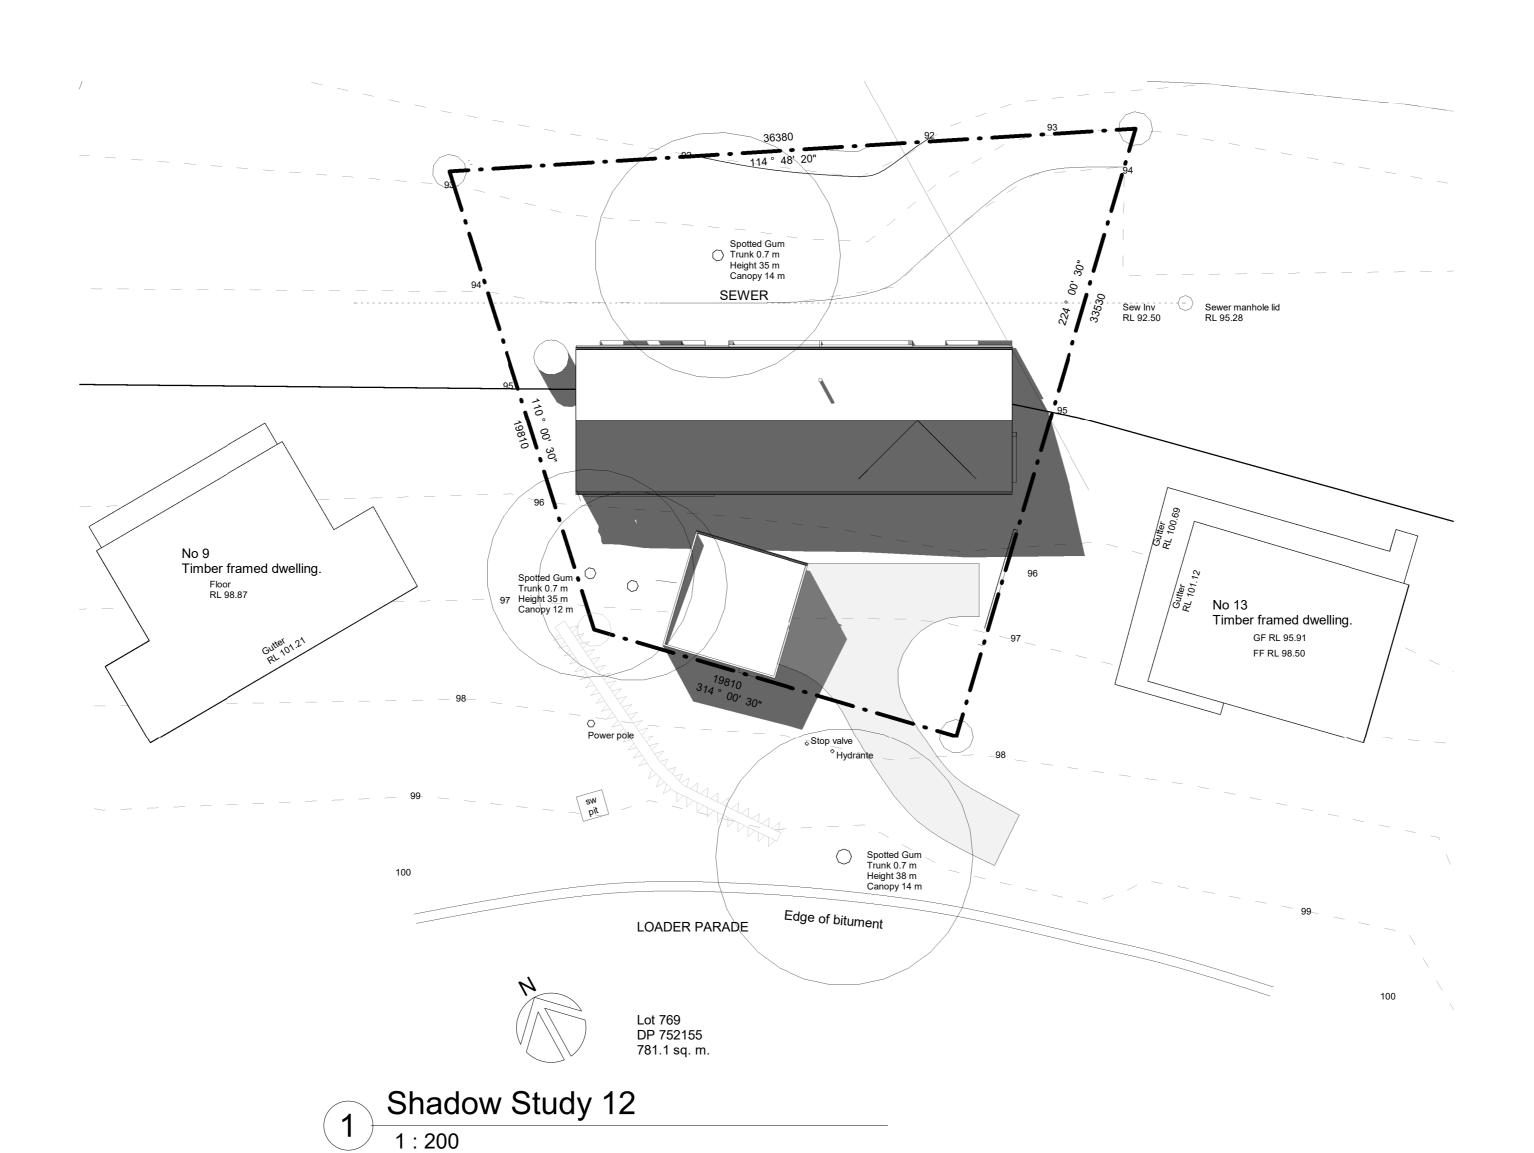
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21/05/2021

Drawing No.

IKW 08



21st June

Altitude 30.3 Azimuth 0.3 Amendment Issue Date

Project

PROPOSEDNEW DWELLING 11 LOADER PARADE NAROOMA

Drawing Title

WORKING DRAWINGS SHADOW STUDY 12:00 PM

Project N

05:21



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1:100 at A2

Drawn

IW

21/05/2021

Drawing No.



21st June

Altitude 16.9 Azimuth 317.5 Amendment Issue Date

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PROPOSEDNEW DWELLING 11 LOADER PARADE NAROOMA

Drawing Title

WORKING DRAWINGS SHADOW STUDY 3:00 PM

Project N

05:21



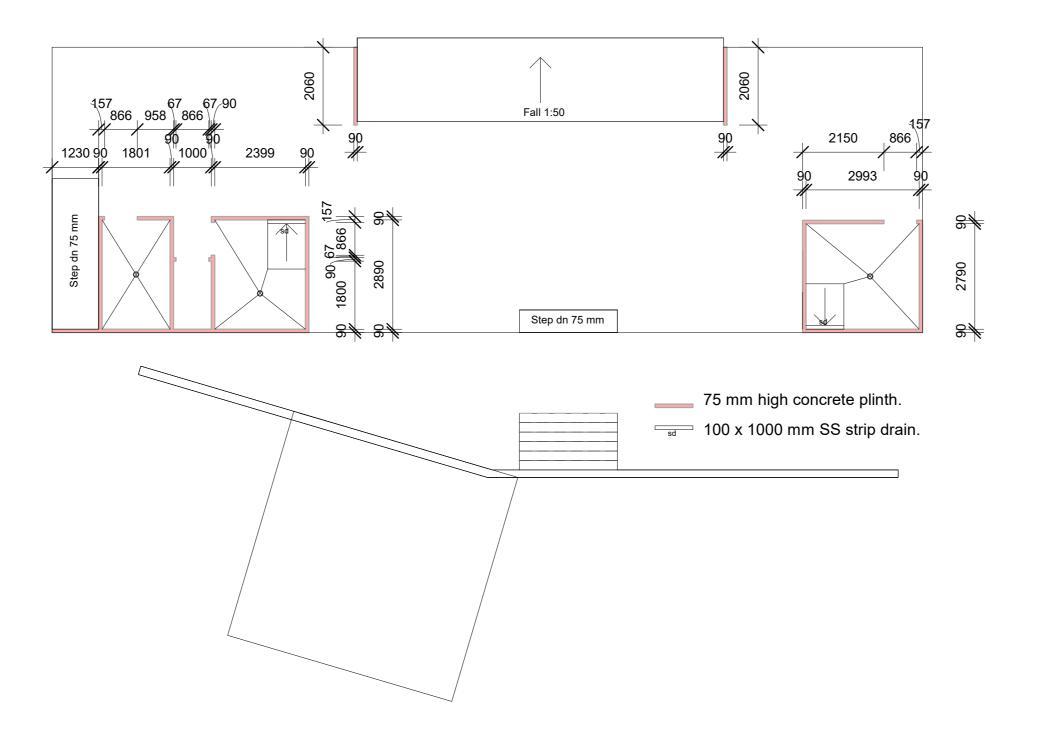
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21/05/2021

Drawing No.



1 Slab Plan 1: 100 Amendment Issue Date

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PROPOSEDNEW DWELLING 11 LOADER PARADE NAROOMA

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WORKING DRAWINGS SLAB DETAILS

Project I

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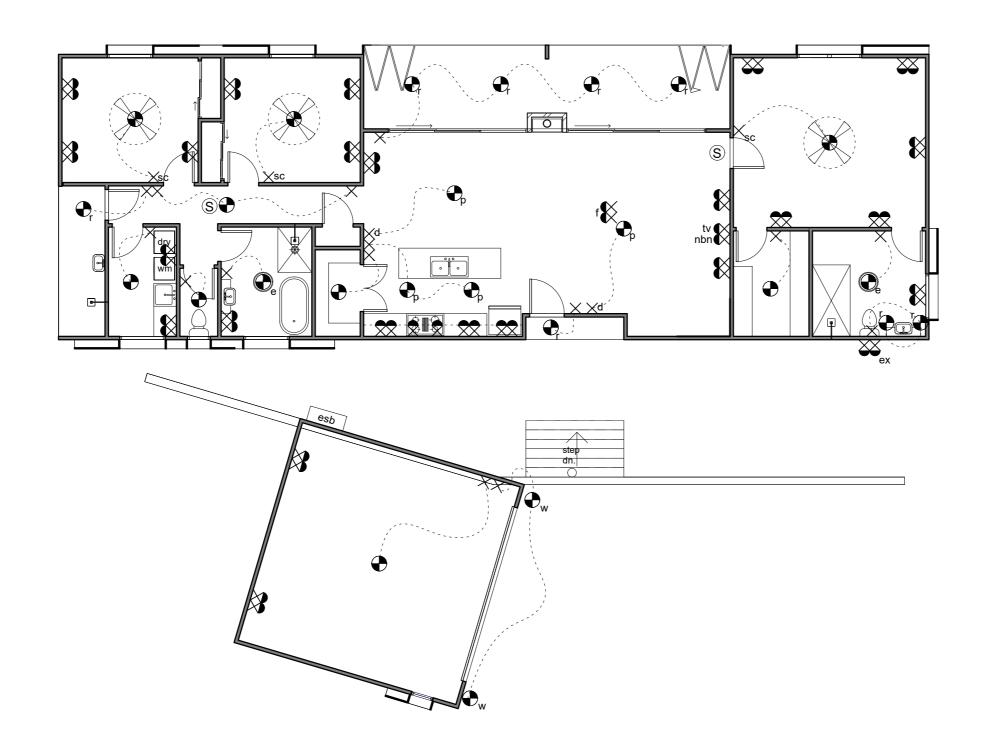
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Drawn IW

14/07/2022

Drawing No.
IKW 18



Electrical Plan

1:100

# LEGEND

S Smoke alarm



Ceiling light & fan

Ceiling light

● Ceiling light & exhaust fan

♣ Wall mounted light

• Recessed ceiling downlight

• Ceiling mounted pendent light

Televsion outlet

nternet outlet

Power outlet double

Power outlet external double

₹ Power outlet floor mounted double

 $imes_{ t d}$  Light switch & fan control & dimmer

× Light switch

esb Electrical switch board

Amendment Issue Date

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PROPOSEDNEW DWELLING 11 LOADER PARADE NAROOMA

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WORKING DRAWINGS ELECTRICAL PLAN

Project No

05



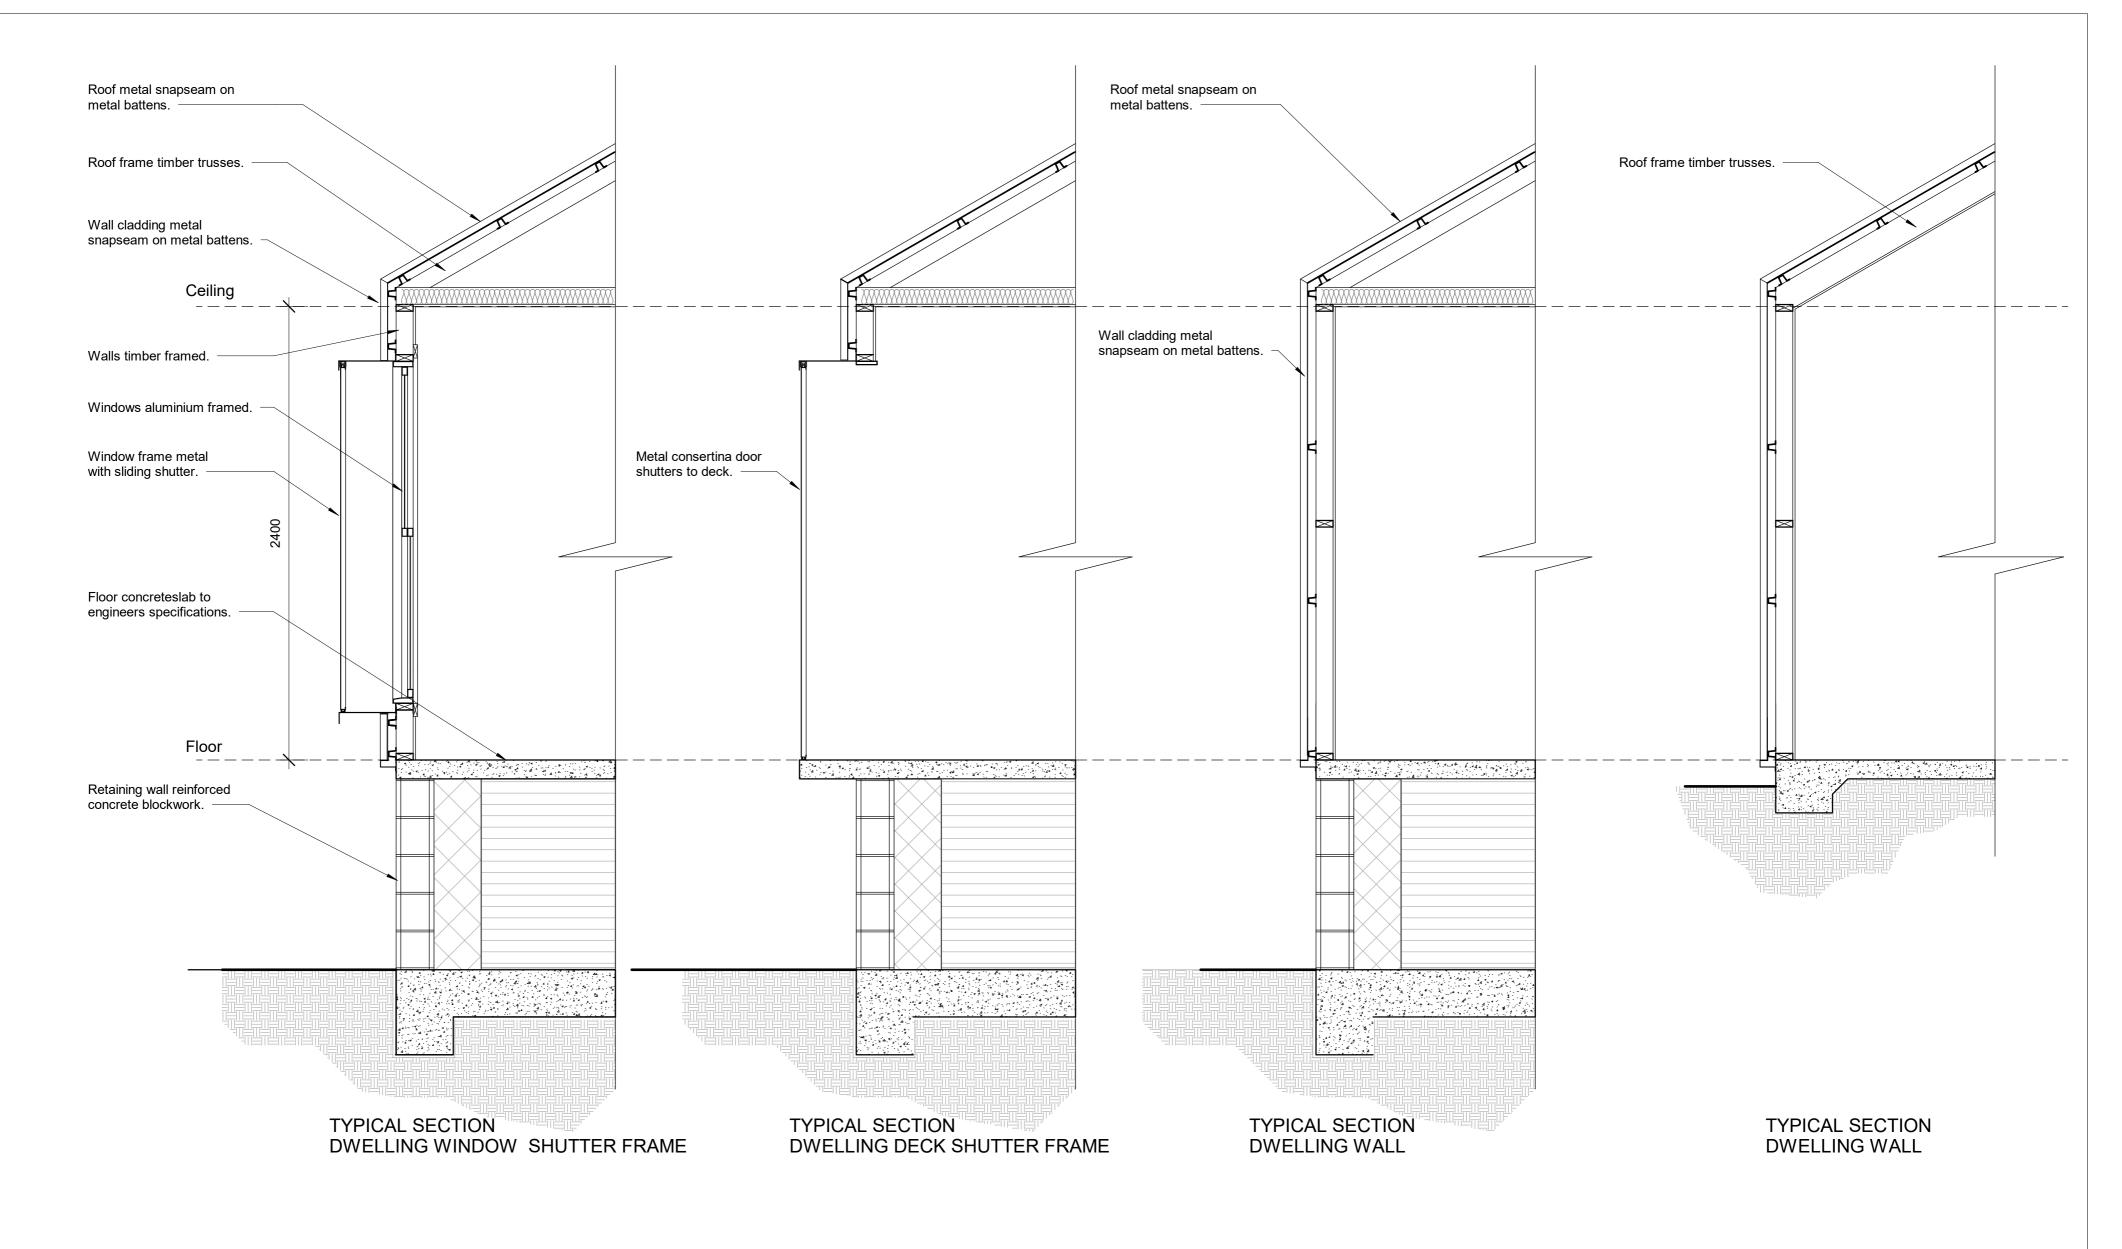
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11/08/2022

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Wall Detail Dwelling



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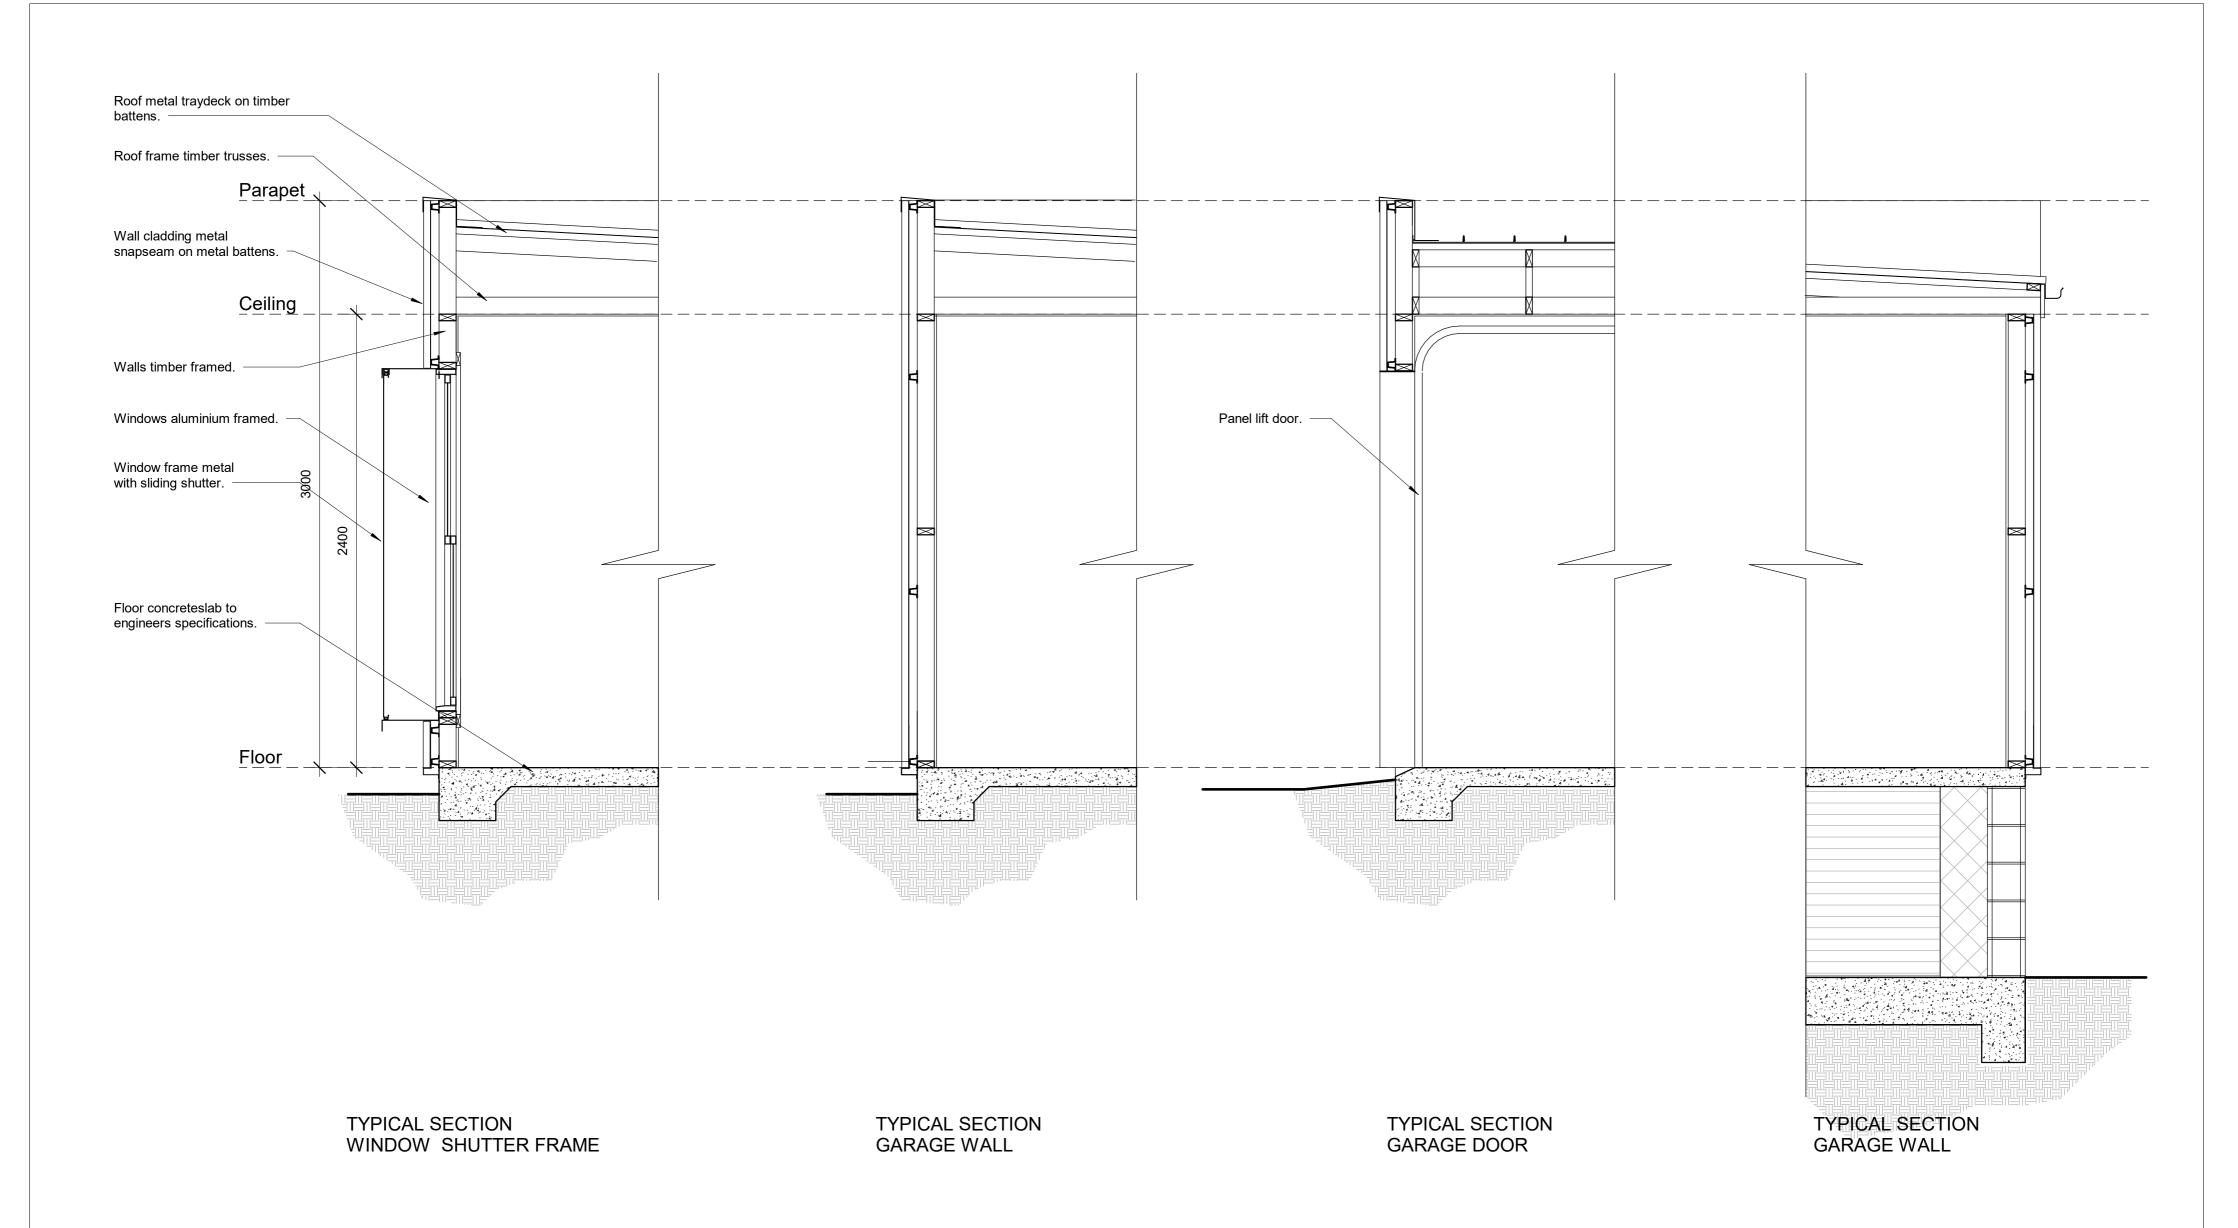
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Scale 1:20 at A2

Drawing 05-21 No.

Drawn IW

Date 23/05/2022







PROPOSEDNEW DWELLING 11 LOADER PARADE NAROOMA

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Scale 1:20 at A2

Drawing 05-21 No.

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Date 23/05/2022